


FRAMING PLAN

DRIP PLATE
SEE DETAIL

NOTE: CAMBER AND DEFLECTION MEASUREMENTS ARE GIVEN IN INCHES TO THE NEAREST SIXTEENTH. MEASUREMENTS INCLUDE BEAM SELF-WEIGHT.

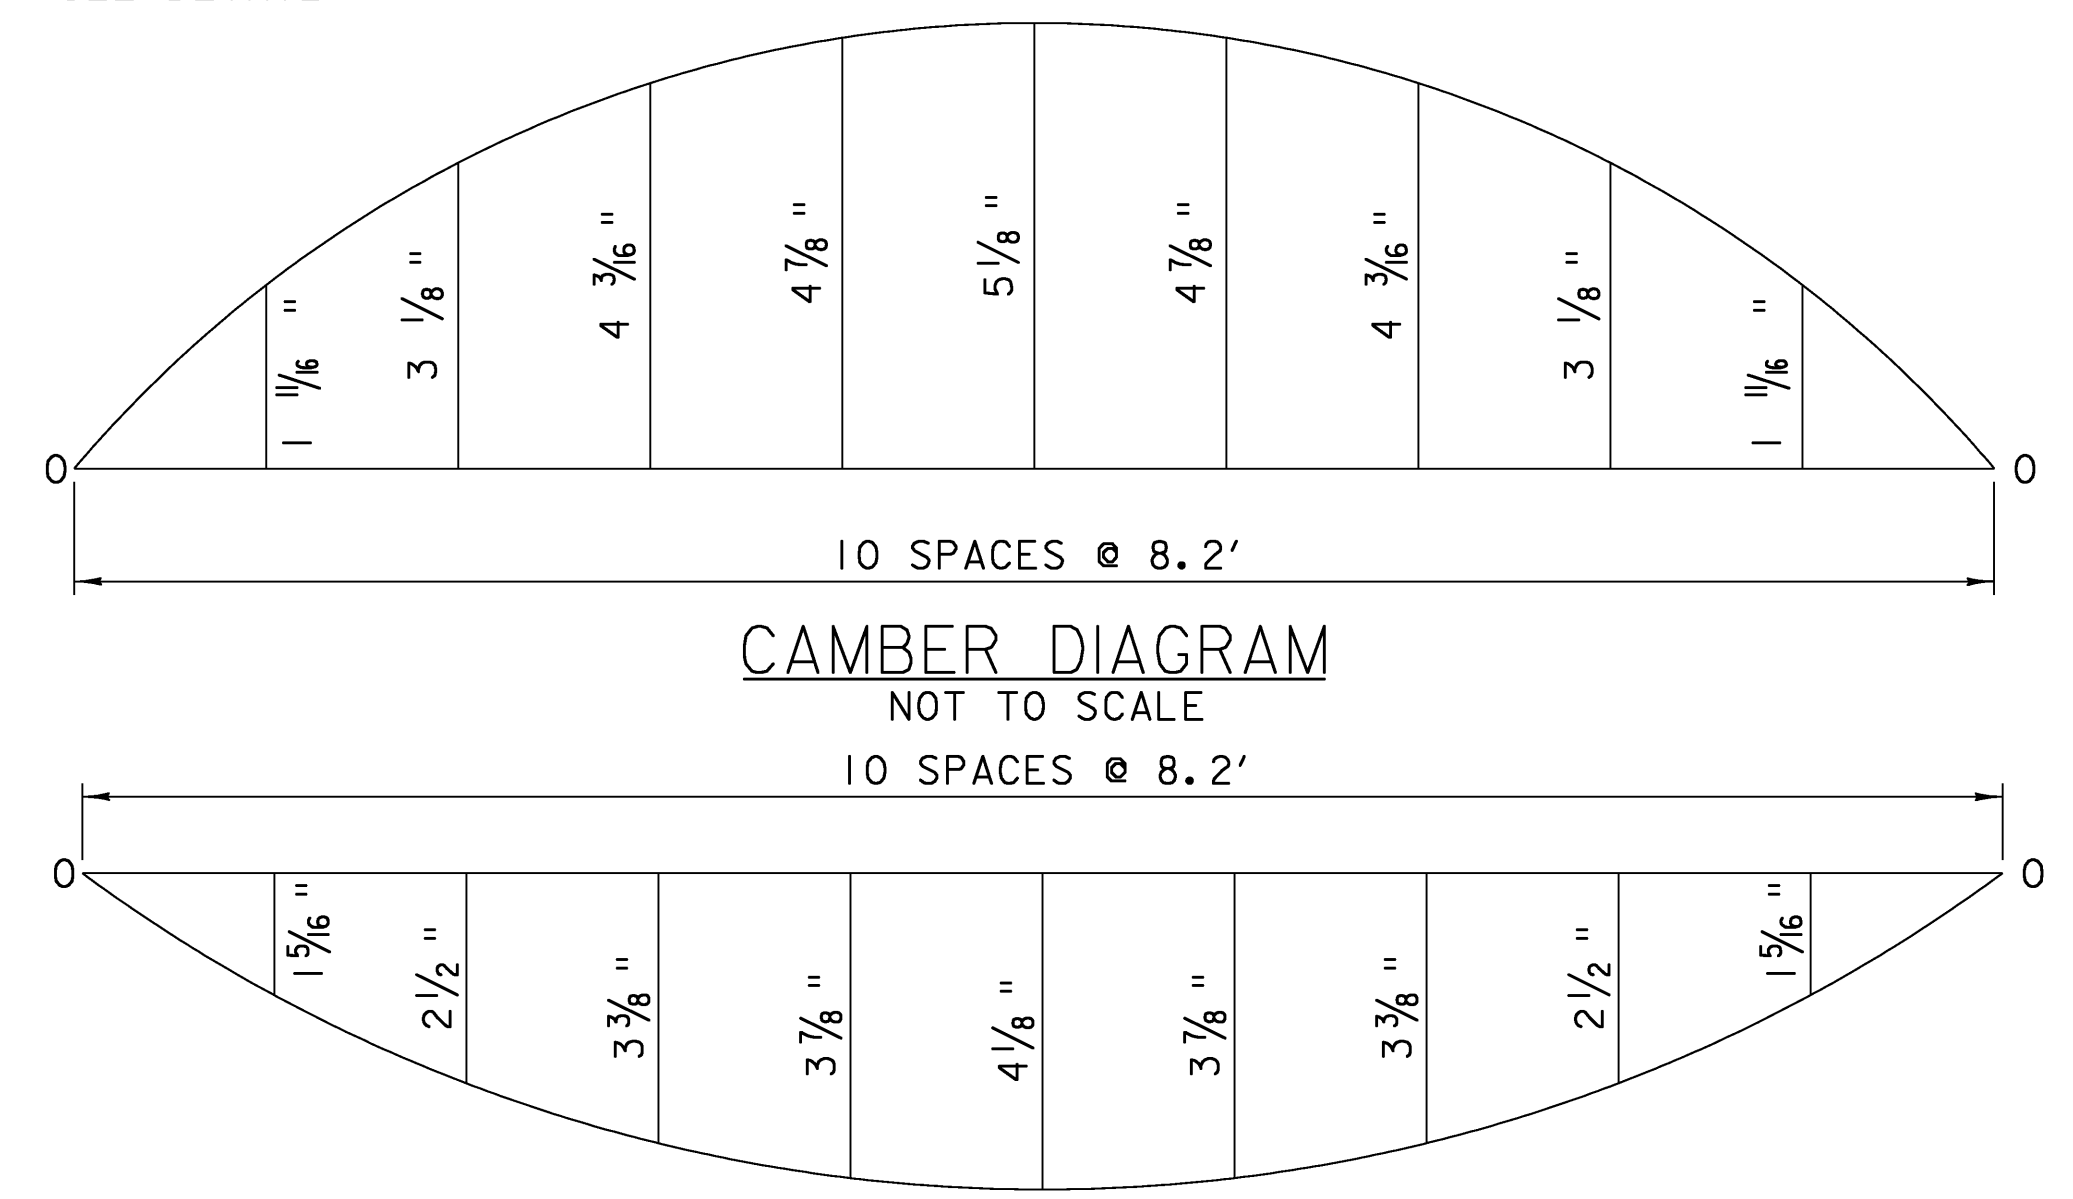


CAMBER DIAGRAM

NOT TO SCALE

10 SPACES @ 8.2'

DEAD LOAD DEFLECTION DIAGRAM

NOT TO SCALE

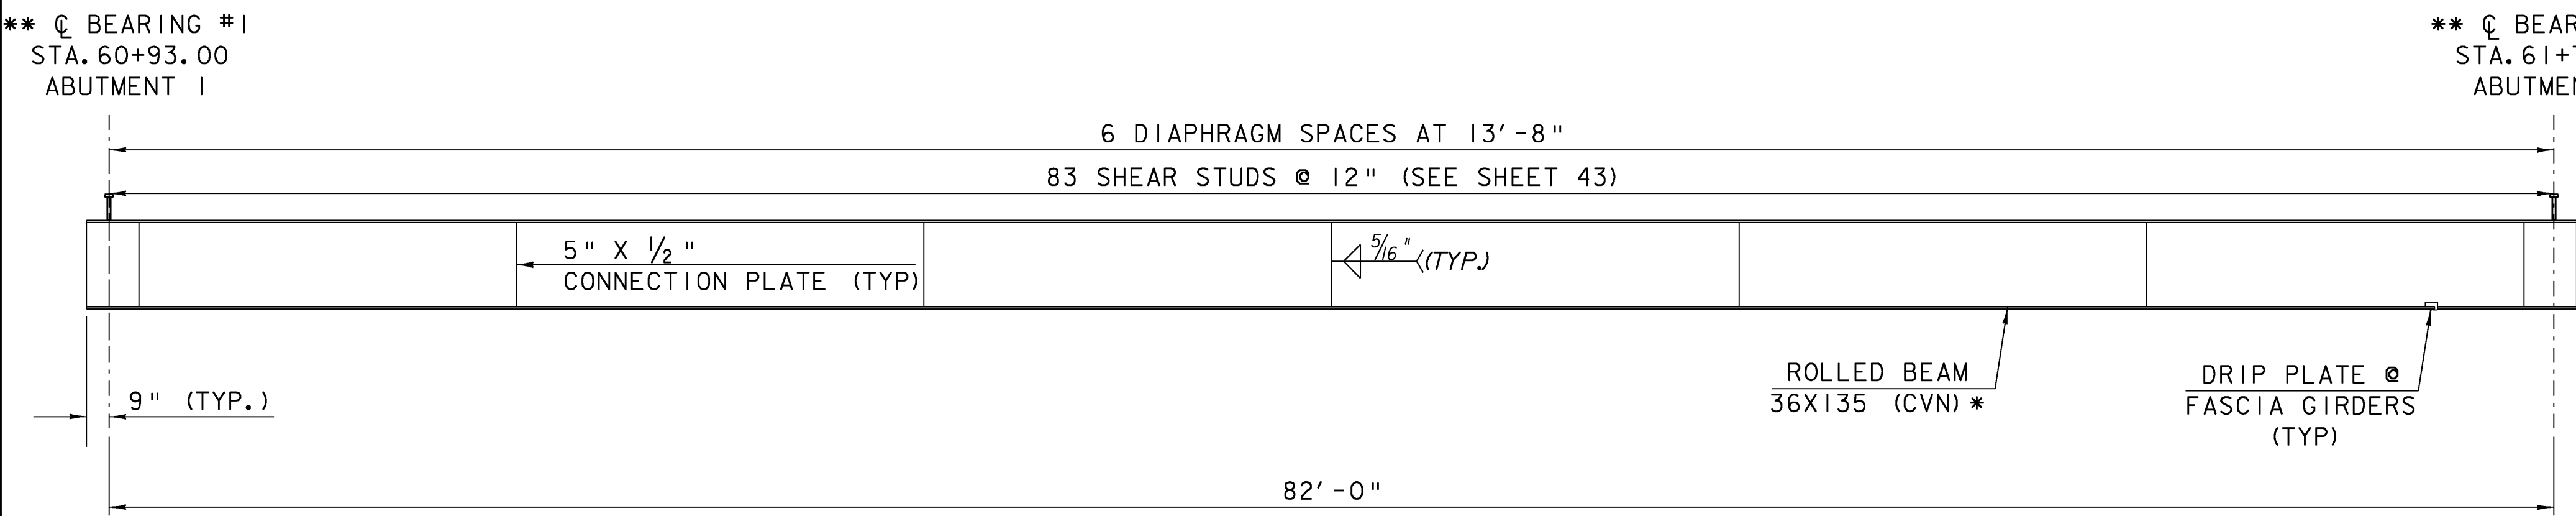

ROLLED BEAMS

** CL BEARING #2
STA. 61+75.00
ABUTMENT 2

** CL BEARING #1
STA. 60+93.00
ABUTMENT 1

SEE SHEET 42 FOR
DETAILS

SCALE 1/4" = 1'-0"
1 0 2 4 6

* CVN - SHALL MEET CHARPY V-NOTCH REQUIREMENTS FOR MAIN MEMBERS AS INDICATED IN SECTION 714 OF THE STANDARD SPECIFICATIONS
** HOLES FOR TRANSVERSE ABUTMENT REINFORCING STEEL NOT SHOWN. SEE SHEET 40

FRAMING PLAN

PROJECT NAME:	CANAAN	PLOT DATE:	18-AUG-2008
PROJECT NUMBER:	ER ST 0271(16)	DRAWN BY:	L. DUQUETTE
FILE NAME:	04c098/struc./s04c098sup	CHECKED BY:	S. SCRIBNER
PROJECT LEADER:	M. EVANS-MONGEON	SHEET	36 OF 66